Allied Engineering J-741 32 Discovery Drive Bozeman, MT 59718

# STATE OF MONTANA DEPARTMENT OF ENVIRONMENTAL QUALITY CERTIFICATE OF SUBDIVISION PLAT APPROVAL (Section 76-4-101 et seq.)

TO: County Clerk and Recorder Gallatin County Bozeman, Montana

E.Q. # 22-1995

THIS IS TO CERTIFY THAT the plans and supplemental information relating to the subdivision known as:

# **Bridger Shadows East Subdivision**

LOT 1 of MINOR SUBDIVISION NO. 502, located in the NW¼ of Section 20, Township 1 South, Range 5 East, P.M.M., Gallatin County, Montana as found in the records of the Gallatin County Clerk & Recorder, containing 23.56 acres and subject to any existing easement of record.

Consisting of 15 lots (Lots 1-13, Open Space A and B) having been reviewed by personnel of the Water Quality Division, and,

THAT the documents and data required by ARM Chapter 17 Section 36 have been submitted and found to be in compliance therewith, and,

THAT the purpose of this proposal is to lift sanitary restrictions from the Lots and Open Spaces, and,

THAT the approval of the Plat and changes made to the previous Certificate of Subdivision Approval is made with the understanding that the following conditions shall be met:

THAT the lot size(s) as indicated on the Plat to be filed with the county clerk and recorder will not be further altered without approval, and,

THAT Open Space A and Open Space B shall be used only for roadways and stormwater ponds as shown on the approved lot layouts, and,

THAT Lots 1-13 shall be used for one living unit not to exceed 5 bedrooms, and,

THAT the number of bedrooms on any lot may be restricted due to engineering design constraints and/or site characteristics of the lot, and,

THAT the approved proposed locations of the individual drinking water well and wastewater treatment system primary disposal and replacement areas shall be staked by the engineer or site evaluator prior to any construction on the lot, and,

THAT the proposed individual drinking water system will consist of a well drilled to a minimum depth of 25 feet constructed in accordance with the criteria established in Title 17, Chapter 36, Sub-Chapters 1, 3, and 6 ARM and the most current standards of the Department of Environmental Quality, and,

THAT data provided indicates an acceptable water source at a depth of approximately 50-70 feet, and, Page 1 of 7

Bridger Shadows East
Gallatin County, Montana
EQ#22-1995 GCCHOA #23-113

2824011

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Eric Semerad - Gallatin County, MT MISC

MISC

THAT the top of the well casing shall be sealed with a screened, vented sanitary well seal which, when installed, creates a watertight seal to prevent the entrance of water or foreign materials into the well, and,

THAT the individual wastewater treatment system will consist of a septic tank, effluent filter and a dose tank followed by an pressure-dosed Elevated Sand Mound, of such size and descriptions as will comply with Title 17, Chapter 36, Sub-Chapters 1, 3 & 6 ARM and the most current standards of the Department of Environmental Quality, and shall be constructed in accordance with the approved plans and specifications provided by Hyalite Engineering of Bozeman, MT, or by equivalent plans and specifications, and,

THAT the footprint of the elevated sand mound will also serve as the replacement area, and,

THAT the elevated sand mound location will need to be staked by a Professional Engineer or Qualified Site Evaluator prior to any construction on the lot, and,

THAT the sand bed part of the Elevated Sand Mound shall be sized at 0.8 gpd/SF, and,

THAT the basal area part of the Elevated Sand Mound shall be sized at 0.3 gpd/SF, and,

THAT the land area 25 feet from the toe of the infiltrative surface on the down gradient side of the elevated sand mound must not be disturbed, and,

THAT the onsite wastewater treatment system shall be protected from both vehicular traffic and livestock trampling, and,

THAT the bottom of the drainfield shall be at least four feet above the seasonal high groundwater table, and,

THAT no sewage treatment system shall be constructed within 100 feet of the maximum high-water level of a 100-year flood of any stream, lake, watercourse, or irrigation ditch, nor within 100 feet of any domestic water supply source, and,

THAT water supply systems, sewage treatment systems and storm drainage systems will be located as shown on the approved plans, and,

THAT the operation and maintenance of water supply, sewage treatment system, and stormwater facilities shall be the responsibility of the lot owner, and,

THAT the stormwater facilities plan was reviewed and approved under EQ#23-2490, dated 5/5/2022, and,

THAT if construction disturbance will exceed 1-acre, a construction stormwater permit from the Department will be required, and,

THAT the developer and/or owner of record shall provide each purchaser of property with a copy of the Plat approved location of water supply, sewage treatment system and storm drainage structures as shown on the attached lot layout, and a copy of this document, and,

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Bridger Shadows East
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THAT instruments of transfer for this property shall contain reference to these conditions, and,

THAT plans and specifications for any proposed sewage treatment systems will be reviewed and approved by the county health department and will comply with local regulations and ARM, Title 17, Chapter 36, Subchapters 3 and 9, in effect when the subdivision application was submitted, and,

THAT departure from any criteria set forth in the approved plans and specifications and Title 17, Chapter 36, Sub-Chapters 1, 3, and 6 ARM when erecting a structure and appurtenant facilities in said subdivision without Department approval, is grounds for injunction by the Department of Environmental Quality, and,

Pursuant to Section 76-4-122 (2)(a), MCA, a person must obtain the approval of both the State under Title 76, Chapter 4, MCA, and local Board of Health under section 50-2-116(1)(i), before filing a subdivision plat with the county clerk and recorder.

YOU ARE REQUESTED to record this certificate by attaching it to the Plat filed in your office as required by law.

DATED this 9<sup>th</sup> day of May 2023.

**REVIEWED AND APPROVED BY:** 

Łori Christenson, MPH

**Health Officer** 

Gallatin City-County Health Department

CHRISTOPHER DORRINGTON,

**DIRECTOR** 

TOR Shawn Rowland, MS RS, Section Sur

Subdivision Section
Engineering Bureau
Water Quality Division

Department of Environmental Quality

Owner's Name: XXX

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Bridger Shadows East
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GENERAL NOTES:

- NO WELLS OR SURFACE WATER WITHIN 100' OF SAND MOUND AREAS.

- WORK SHALL BE PERFORMED IN ACCORDANCE TO MDEQ CIRCULAR 4 AND GALLATIN COUNTY, MT.

TY EASEMENT PER DOC #2688079

- COUNTY, MT.

  CLOSED COMPONENTS (SEPTIC TANK, DOSING TANK, SERVICE PIPE, FORCEMAIN, ETC.)

  SHALL MAINTAIN 50' MINIMUM FROM SURFACE WATER AND WELLS.

  INSTALL SEWER SERVICE CLEAN-OUTS AS REQUIRED BY GALLATIN COUNTY.

  WASTEWATER SYSTEM COMPONENTS SHALL MAINTAIN 10' MINIMUM SEPARATION FROM ALL LOT LINES, WATER LINES, AND STRUCTURES.

  CONTRACTOR RESPONSIBLE FOR UTILITY LOCATE PRIOR TO DIGGING OR DRILLING.

  CONTRACTOR RESPONSIBLE FOR MEETING ALL UTILITY REQUIREMENTS.

  INSTALLER SHALL BE LICENSED AND QUALIFIED TO INSTALL WASTEWATER SYSTEMS IN GALLATIN COUNTY, MT.

  CONTRACTOR SHALL VERIEY ALL PROJECT SITE CONDITIONS AND NOTIFY THE ENGINEER.

- CONTRACTOR SHALL VERIFY ALL PROJECT SITE CONDITIONS AND NOTIFY THE ENGINEER OF ANY DISCREPANCIES IN WRITING.

- SITE SPECIFIC NOTES:

   ALL ELEVATED SAND MOUNDS WERE DESIGNED WITH PRESSURE-DOSED 3-FT WIDE GRAVEL-LESS INFILTRATOR CHAMBERS TO SERVE ONE (1) SINGLE FAMILY DWELLING WITH
- UP TO 5-BEDROOMS (400-GPD).

  SIZING OF THE WASTEWATER TREATMENT SYSTEM WAS BASED ON AN APPLICATION RATE OF 0.8 GPD/FT<sup>2</sup>, RESULTING IN A REQUIRED TOTAL AREA OF 500 SQ FT OF BED AREA FOR ALL LOTS. SEE DETAILS FOR PRIMARY & 100% REPLACEMENT BASAL AREA DIMENSIONS.
- THE 2" SCH 40 PVC FORCEMAIN SHALL MAINTAIN GRADE TO ELEVATED SAND MOUND SO 100% DRAINAGE CAN BE OBTAINED BETWEEN DOSE CYCLES. (I.E. NO HUMPS OR DELINE) TO ANNUAL EMPERIOR DOTAINAGE.
- BELLIES) TO MINIMIZE FREEZING POTENTIAL.

  CONTRACTOR SHALL INSTALL ALL OTHER COMPONENTS IN COMPLIANCE WITH GALLATIN COUNTY AND DEQ CIRCULAR 4 REGULATIONS.
- CONTRACTOR SHALL INSULATE ALL APPLICABLE WASTEWATER TREATMENT SYSTEM COMPONENTS NECESSARY TO MINIMIZE FREEZING POTENTIAL.


  CONTRACTOR TO COORDINATE ALL UTILITY CROSSINGS AND POTENTIAL CONFLICTS WITH
- APPROPRIATE UTILITY AGENCIES/COMPANIES. CONTRACTOR TO FIELD VERIFY ACTUAL LOCATIONS AND DEPTHS OF EXISTING UTILITIES PRIOR TO CONSTRUCTION. EASEMENTS SHOWN MAY NOT INCLUDE ALL EASEMENTS OF RECORD, MAY NOT REFLECT EASEMENTS THAT HAVE SUBSEQUENTLY BEEN VACATED/REMOVED, AND ARE SHOWN FOR
- CONCEPTUAL/PLANNING PURPOSES ONLY.

  SETBACKS SHOWN MAY NOT BE ALL INCLUSIVE, REPRESENT THE BEST AVAILABLE INFORMATION TO THE ENGINEER AT THIS TIME, AND ARE SHOWN FOR CONCEPTUAL/PLANNING PURPOSES ONLY.
- ON-SITE GRADING MAY REQUIRE MODIFICATION TO SEWER SERVICE, SEPTIC TANK, AND DOSING TANK LOCATIONS. ENGINEER MUST BE CONTACTED TO CONDUCT A PRESSURE DESIGN PRIOR TO RELOCATION OF COMPONENTS.

  CONTRACTOR TO FIELD VERIFY ALL EXISTING WASTEWATER AND POTABLE WATER SUPPLY
- LOCATIONS. INSTALL 15" DIAMETER CMP CULVERT (OR APPROVED EQUIVALENT) AT THE DRIVEWAY
- INSTALL 15' DIAMETER CMP CULVERT (OR APPROVED EQUIVALENT) AT THE DRIVEWAY APPROACHES FOR ALL LOTS.

   POTENTIAL LOCATIONS OF HOMES, DRIVEWAYS, SEPTIC TANKS, DOSE TANKS, FORCE MAINS, ETC. HAVE BEEN SHOWN FOR CONCEPTUAL PURPOSES ONLY. FUTURE LOCATIONS OF AFOREMENTIONED ITEMS MAY VARY FROM LOT LAYOUT. VERIFY SETBACKS WITH ZONING REQUIREMENTS AND ANY OTHER SETBACK REQUIREMENTS.

   ALTERNATE: IN LIEU OF GRAVEL—LESS INFILITRATOR CHAMBERS, A GRAVEL BED SYSTEM MAY BE INSTALLED. IF ALTERNATIVE IF PROPOSED, CONTRACTOR SHALL CONTACT ENGINEER PRIOR TO CONSTRUCTION.
- ROAD DRAINAGE SHALL BE DIRECTED TO THE NORTHERN STORMWATER POND/EASEMENT SHOWN.

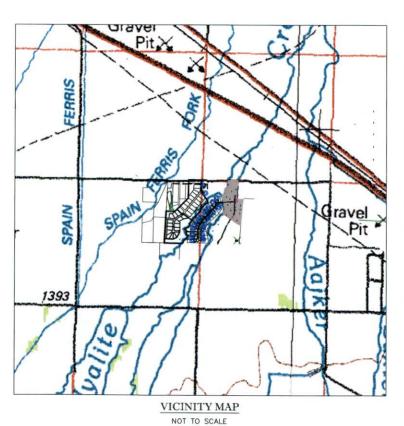


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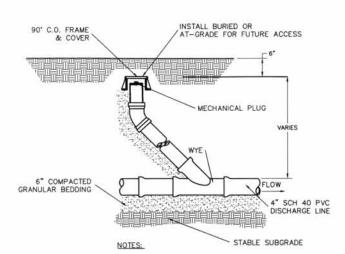
SCALE (FEET)

REVIEWED BY: MAF

PROJECT ENGINEER: MAF



NE 1/4 SEC 19 & NW 1/4 SEC 20, T1S, R5E, P.M.M., GALLATIN COUNTY

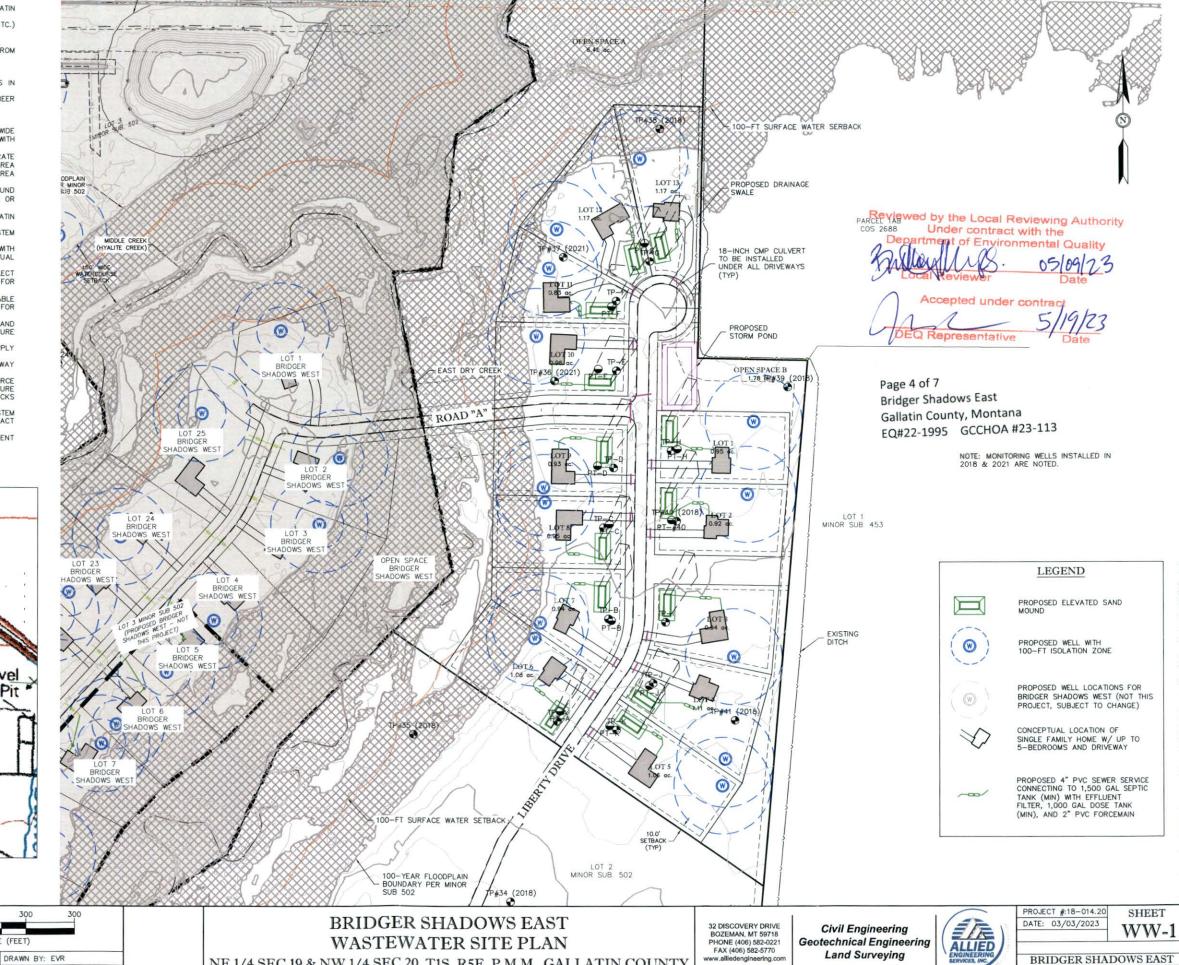

USE INLAND FOUNDRY MODEL 240 FRAME & COVER

IN ALL TRAFFIC AREAS.
COVER AND FRAME SHALL BE GRAY CAST IRON
ASTM A-48, CLASS 30.
COVER AND FRAME TO BE MACHINED TO A TRUE

BEARING ALL AROUND.
PROVIDE 6" FOREWHOLD SHIPE TISPECTREDATOR OVIEWING AUTIMOEOU/5.1.2.1.: Under contract with the

LIQUID CONNECTION BETWEEN COMPARTMENTS SHALL CONSIST OF A SINGLE OPENING COMPLETELY ACROSS THE COMPARTMENT WALL OR TWO OPENINGS EQUALLY SPACED ACROSS THE WALL. THE TOTAL AREA OF THE OPENINGS SHALL BE AT LEAST THREE TIMES THE AREA OF THE INLET PIPE.

\*INSTALL SAFETY GRATES AT ALL SEPTIC TANK/DOSING TANK OPENINGS. CUT TO FIT AROUND EFFLUENT FILTER HANDLE AND PUMP DISCHARGE PIPING (IF NECESSARY).

ALTERNATE
\*OWNER MAY INSTALL FIBERGLASS RISERS AND LIDS IN LIEU

\*PRIOR TO PLACEMENT OF TANKS CONTACT ENGINEER IF

TANK DEPTHS ARE ANTICIPATED TO EXCEED 4' BURY DEPTH.

OF CONCRETE. RISERS AND LIDS (TYPICAL ALL TANKS)

ALL SEPTIC AND DOSING TANKS MUST BE TESTED IN ACCORDANCE WITH MDEQ4 CHAPTER 5 FOR WATERTIGHTNESS.

24" DIA, RISER AND LID

20" DIA. ACCESS


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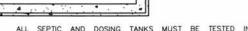
**Bridger Shadows East** 

Gallatin County, Montana

WATER TESTING MUST BE CONDUCTED BY SEALING THE OUTLETS, FILLING THE SEPTIC TANK TO ITS OPERATIONAL LEVEL, AND ALLOWING THE TANK TO STAND FOR AT LEAST 24 HOURS. IF THERE IS A MEASURABLE LOSS (2 INCHES OR MORE), REFILL THE TANK AND LET STAND FOR ANOTHER 24 HOURS. IF THERE IS AGAIN A MEASURABLE LOSS, THE TANK MUST BE REJECTED.

VACUUM TESTING MUST BE CONDUCTED BY SEALING ALL INLETS, OUTLETS, AND ACCESSES, THEN INTRODUCING A VACUUM OF 4 INCHES OF MERCURY, IF THE VACUUM DROPS IN THE FIRST 5 MINUTES IT MUST BE BROUGHT BACK TO 4 INCHES OF MERCURY. IF THE SEPTIC TANK FAILS TO HOLD THE VACUUM AT 5 INCHES OF MERCURY FOR 5 MINUTES, THE TANK MUST BE REJECTED.



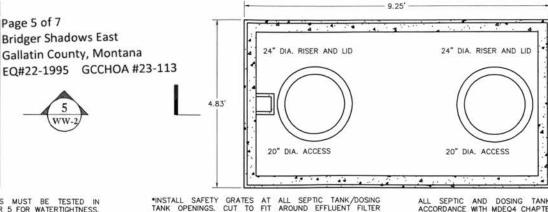

ALTERNATE
\*OWNER MAY INSTALL FIBERGLASS RISERS AND LIDS IN LIEU OF CONCRETE. RISERS AND LIDS (TYPICAL ALL TANKS)

\*PRIOR TO PLACEMENT OF TANKS CONTACT ENGINEER II TANK DEPTHS ARE ANTICIPATED TO EXCEED 4' BURY DEPTH

HANDLE AND PUMP DISCHARGE PIPING (IF NECESSARY).

SAFETY GRATE

4.58 INLE

TANK NOTES:

AND DRAIN PIPE.

NORMALLY SET IN ONE PIECE

WEIGHT OF TANK IS 11,000 LBS.

10. MAXIMUM EARTH COVER IS 4 FEET.

SIDE INLET (KNOCK-OUTS) PROVIDED

REINFORCING = #3 REBAR GRADE 40. ACTUAL CAPACITY = 996 GALLONS.

EACH SEGMENT IS POURED MONOLITHICALLY.
ALL HANDLES ARE 1/4" SMOOTH STEEL.

DETAIL (PROFILE VIEW)

LIQUID CONNECTION BETWEEN COMPARTMENTS SHALL CONSIST OF A SINGLE OPENING COMPLETELY ACROSS THE COMPARTMENT WALL OR TWO OR MORE OPENINGS EQUALLY SPACED ACROSS THE WALL. THE TOTAL AREA OF THE OPENINGS SHALL BE AT LEAST THREE TIMES THE AREA OF THE INLET PIPE.

DETAIL (PLAN VIEW)

ACCORDANCE WITH MDEQ4 CHAPTER 5 FOR WATERTIGHTNESS

WATER TESTING MUST BE CONDUCTED BY SEALING THE OUTLETS, FILLING THE SEPTIC TANK TO 1TS OPERATIONAL LEVEL, AND ALLOWING THE TANK TO STAND FOR AT LEAST 24 HOURS. IF THERE IS A MEASURABLE LOSS (2 INCHES OR MORE), REFILL THE TANK AND LET STAND FOR ANOTHER 24 HOURS. IF THERE IS AGAIN A MEASURABLE LOSS, THE TANK MUST BE REJECTED

1,000 GALLON SINGLE COMPARTMENT DOSE TANK (NOT TRAFFIC RATED)
NOT TO SCALE

A' MAX.

RECOMMENDED

SPLICE BOX

TO CONTROL

ALARM

VACUUM TESTING MUST BE CONDUCTED BY SEALING ALL INLETS, OUTLETS, AND ACCESSES, THEN INTRODUCING A VACUUM OF 4 INCHES OF MERCURY, IF THE VACUUM DROPS IN THE FIRST 5 MINUTES IT MUST BE BROUGHT BACK TO 4 INCHES OF MERCURY, IF THE SEPTIC TANK FAILS TO HOLD THE VACUUM AT 4 INCHES OF MERCURY FOR 5 MINUTES, THE TANK MUST BE REJECTED.

TYPICAL ALL RISERS)

PVC UNION

5.58

OUTLET

SAFETY GRATE DRILL %6" WEEP HOLE

24" DIA CONCRETE ACCESS RISER AND CONCRETE LID (HEIGHT TO BE DETERMINED BY INSTALLER PER FIELD INSTALLATION,

2" SCH. 40 PVC FORCEMAIN

(COMPLETELY DRAIN B/W DOSE CYCLES)


## DETAIL (PLAN VIEW) - PRIMARY HOME

DIA RISER AND LID

20" DIA. ACCESS

ww.2 1,500 GALLON DOUBLE COMPARTMENT SEPTIC TANK (NOT TRAFFIC RATED) NOT TO SCALE

11.33

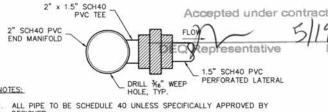

- 2. ORIFICES TO BE 1/2" DIA. SPACED 5' ON CENTER FACING UPWARD WITH EVERY FIRST, FOURTH, AND LAST ORIFICE FACING DOWNWARD (USE ORIFICE SHIELD ON DOWNWARD FACING ORIFICES) (FOR INFILTRATOR CHAMBERS).
- A SUCCESSFUL SQUIRT TEST WILL DEMONSTRATE LESS THAN 10% VARIATION IN FLOW ACROSS THE FIELD.



### GENERAL NOTES:

1 DETAIL

ww-3 4" CLEANOUT

NOT TO SCALE

- WORK SHALL BE PERFORMED IN ACCORDANCE WITH CIRCULAR DEQ 4, AND GALLATIN COUNTY
- REGULATIONS.
  2. CONTRACTOR SHALL BE LICENSED AND QUALIFIED TO INSTALL WASTEWATER TREATMENT SYSTEMS IN GALLATIN COUNTY, MONTANA,
- NO WELLS OR SURFACE WATER EXIST WITHIN 100 FEET OF PRIMARY ABSORPTION AREA OF 100% REPLACEMENT AREA.
- 4. NO WELLS OR SURFACE WATER EXIST WITHIN 50 FEET OF WASTEWATER TREATMENT SYSTEM'S
- SEALED COMPONENTS.

  5. SURFACE DRAINAGE IS ADEQUATE.

- CONTRACTOR TO VERIFY LOCATION OF ALL UTILITIES PRIOR TO CONSTRUCTION ACTIVITIES. CONTRACTOR TO VERIFY SEWER STUB LOCATIONS PRIOR TO INSTALLATION OF WASTEWATER
- CONTRACTOR TO FIELD VERIFY ALL APPLICABLE SETBACKS PRIOR TO INSTALLATION OF WASTEWATER TREATMENT SYSTEM. IF ANY DISCREPANCIES ARE DETERMINED BY CONTRACTOR, ENGINEER SHALL BE NOTIFIED IMMEDIATELY IN WRITING.
- 10 FEET (MIN.) SEPARATION BETWEEN WATER AND SEWER LINES SHALL BE MAINTAINED.
- 5. THERE IS THREE INCHES (3") OF FALL BETWEEN INLET AND OUTLET OF TANKS. INSTALLER TO PROVIDE 1% (MIN.) SLOPE BETWEEN OUTLET OF SEPTIC TANK AND INLET OF DOSE TANK.


  6. ANY DESIGN CHANGES WITH RESPECT TO ORIENTATION, LAYOUT, MATERIALS, ETC. MUST BE
- APPROVED BY ENGINEER.

  7. THE PRIMARY ABSORPTION AREA HAS BEEN DESIGNED TO COMPLETELY DRAIN TO THE DOSE
- TANK BETWEEN DOSES. CONTRACTOR SHALL INSTALL FORCEMAIN AT CONSTANT GRADE (I.E. NO HUMPS OR BELLIES) TO ALLOW FOR DRAINAGE.
- NO HOMPS OR BELLIES) TO ALLOW FOR DRAINAGE.

  8. CONTRACTOR SHALL INSULATE ALL APPLICABLE WASTEWATER TREATMENT SYSTEM COMPONENTS TO PROHIBIT FREEZING OF ANY AND ALL SYSTEM COMPONENTS.

  9. ALL TANK DETAILS REFLECT STANDARD TANK CONSTRUCTION. CONTRACTOR MAY CHOOSE ALTERNATIVE. IF ALTERNATIVE IS CHOSEN, CONTRACTOR SHALL OBTAIN APPROVAL FROM THE ENGINEER PRIOR TO CONSTRUCTION.
- 10. IF HOME LOCATIONS AND/OR TANK CONFIGURATIONS/LOCATIONS VARY FROM PROPOSED SITE PLAN, CONTRACTOR SHALL NOTIFY ENGINEER AND REQUEST VERIFICATION OF FLOAT SETTINGS,
- HYDRAULIC CALCULATIONS, ETC.

  11. GRAVEL TRENCHES MAY BE USED IN LIEU OF INFILTRATOR CHAMBERS, CONTACT ENGINEER FOR

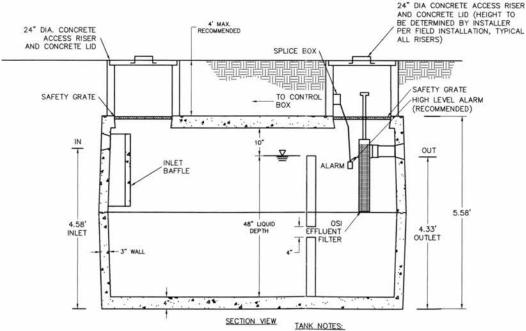

- ALL SEPTIC TANK DIMENSIONS HAVE BEEN SUPPLIED BY ANDERSON PRECAST & SUPPLY, INC (BOZEMAN, MT). CONTRACTOR MAY ELECT TO USE ALTERNATIVE SUPPLIER, IN WHICH CASE CONTRACTOR SHALL SUBMIT STANDARD SEPTIC TANK DETAILS PER SUPPLIERS PROPOSED CONSTRUCTION PRIOR TO INSTALLATION.
- WE RECOMMEND THE USE OF A HIGH LEVEL ALARM.
- CONCRETE IS 5,000 PSI AT 28 DAYS INLET AND OUTLET HAVE PLASTIC SEAL WHICH ACCEPTS SCH40 OR SEWER AND DRAIN PIPE, NORMALLY SET IN ONE PIECE
- SIDE INLET (KNOCK-OUTS) PROVIDED. EACH SEGMENT IS POURED MONOLITHICALLY.
- ALL HANDLES ARE 1/4" SMOOTH STEEL. WEIGHT OF TANK IS 16,000 LBS. REINFORCING = #3 REBAR GRADE 40. ACTUAL CAPACITY = ±1,500 GALLONS

- 10. MAXIMUM EARTH COVER IS 4 FEET.
  11. TANK JOINT IS SEALED WITH 3/4" DIA. CONSEAL.

## DETAIL (PROFILE VIEW) - PRIMARY HOME

WW-2 1,500 GALLON DOUBLE COMPARTMENT SEPTIC TANK (NOT TRAFFIC RATED)

NO.	REVISIONS	DRAWN BY	DATE			
				-		
_				-		
				PROJECT ENGINEER: MAF	DRAWN BY: EVR	1
_				DESIGNED BY: EVR	REVIEWED BY: MAF	1

## BRIDGER SHADOWS EAST GENERAL DETAILS

NE 1/4 SEC 19 & NW 1/4 SEC 20, T1S, R5E, P.M.M., GALLATIN COUNTY

32 DISCOVERY DRIVE BOZEMAN, MT 59718 PHONE (406) 582-0221 FAX (406) 582-5770 www.alliedengineering.com

NOT TO SCALE

Civil Engineering Land Surveying

WW-2 1,000 GALLON SINGLE COMPARTMENT DOSE TANK (NOT TRAFFIC RATED)



PROJECT #:18-014.20 SHEET DATE: 03/03/2023 WW-2

SUBMERSIBLE ASHLAND PUMP WITH AN ORENCO SI CONTROL PANEL AND ANCHOR

BRAND 10' MINI FLOATS. SEE WW-3 FOR HYDRAULIC SPECIFICATIONS.

Geotechnical Engineering


SECTION VIEW

11. TANK JOINT IS SEALED WITH 3/4" DIA. CONSEAL.
12. ALL SEPTIC TANK DIMENSIONS HAVE BEEN SUPPLIED BY ANDERSON PRECAST &

SUPPLY, INC (BOZEMAN, MT). CONTRACTOR MAY ELECT TO USE ALTERNATIVE SUPPLIER, IN WHICH CASE CONTRACTOR SHALL SUBMIT STANDARD SEPTIC TANK DETAILS PER SUPPLIERS PROPOSED CONSTRUCTION PRIOR TO INSTALLATION.

CONCRETE IS 5,000 PSI AT 28 DAYS INLET AND OUTLET HAVE PLASTIC SEAL WHICH ACCEPTS SCH. 40 OR SEWER

BRIDGER SHADOWS EAST

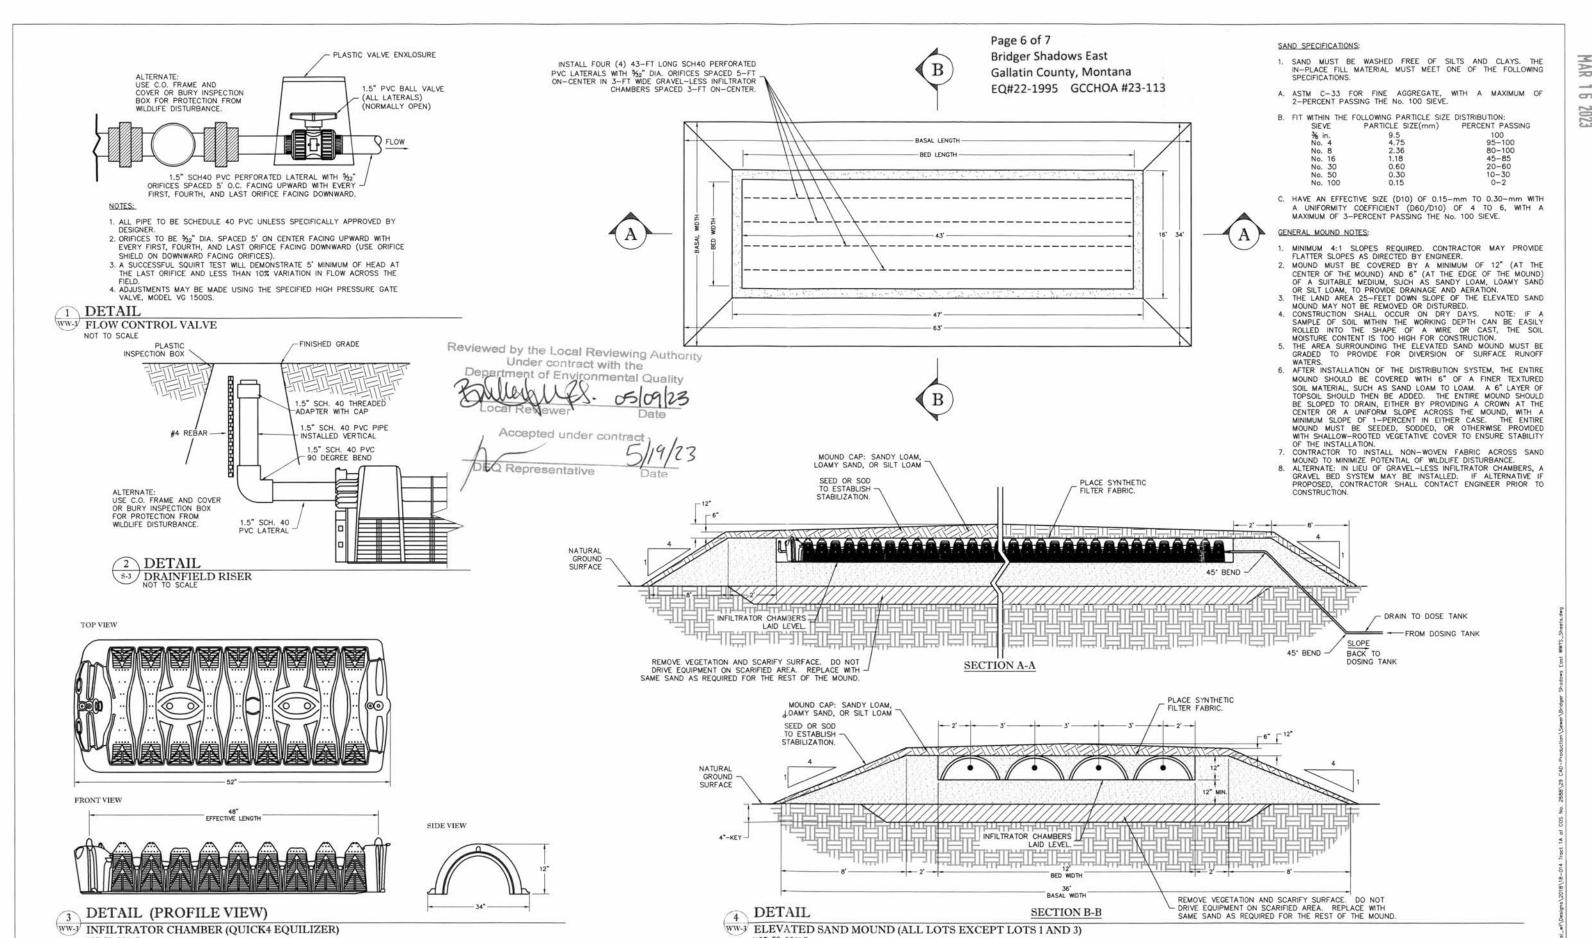

REVISIONS DRAWN BY DATE SCALE AS NOTED PROJECT ENGINEER: MAF DRAWN BY: EVR REVIEWED BY: MAF

# BRIDGER SHADOWS EAST GENERAL DETAILS

PHONE (406) 582-0221 FAX (406) 582-5770

32 DISCOVERY DRIVE

BOZEMAN, MT 59718

Land Surveying



PROJECT #:18-014.20 DATE: 03/03/2023


SHEET WW-3

BRIDGER SHADOWS EAST

NE 1/4 SEC 19 & NW 1/4 SEC 20, T1S, R5E, P.M.M., GALLATIN COUNTY

Civil Engineering Geotechnical Engineering

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NO.	REVISIONS	DRAWN BY	DATE			
				4		- 1
				PROJECT ENGINEER: MAF	DRAWN BY: EVR	
				DESIGNED BY: EVR	REVIEWED BY: MAF	
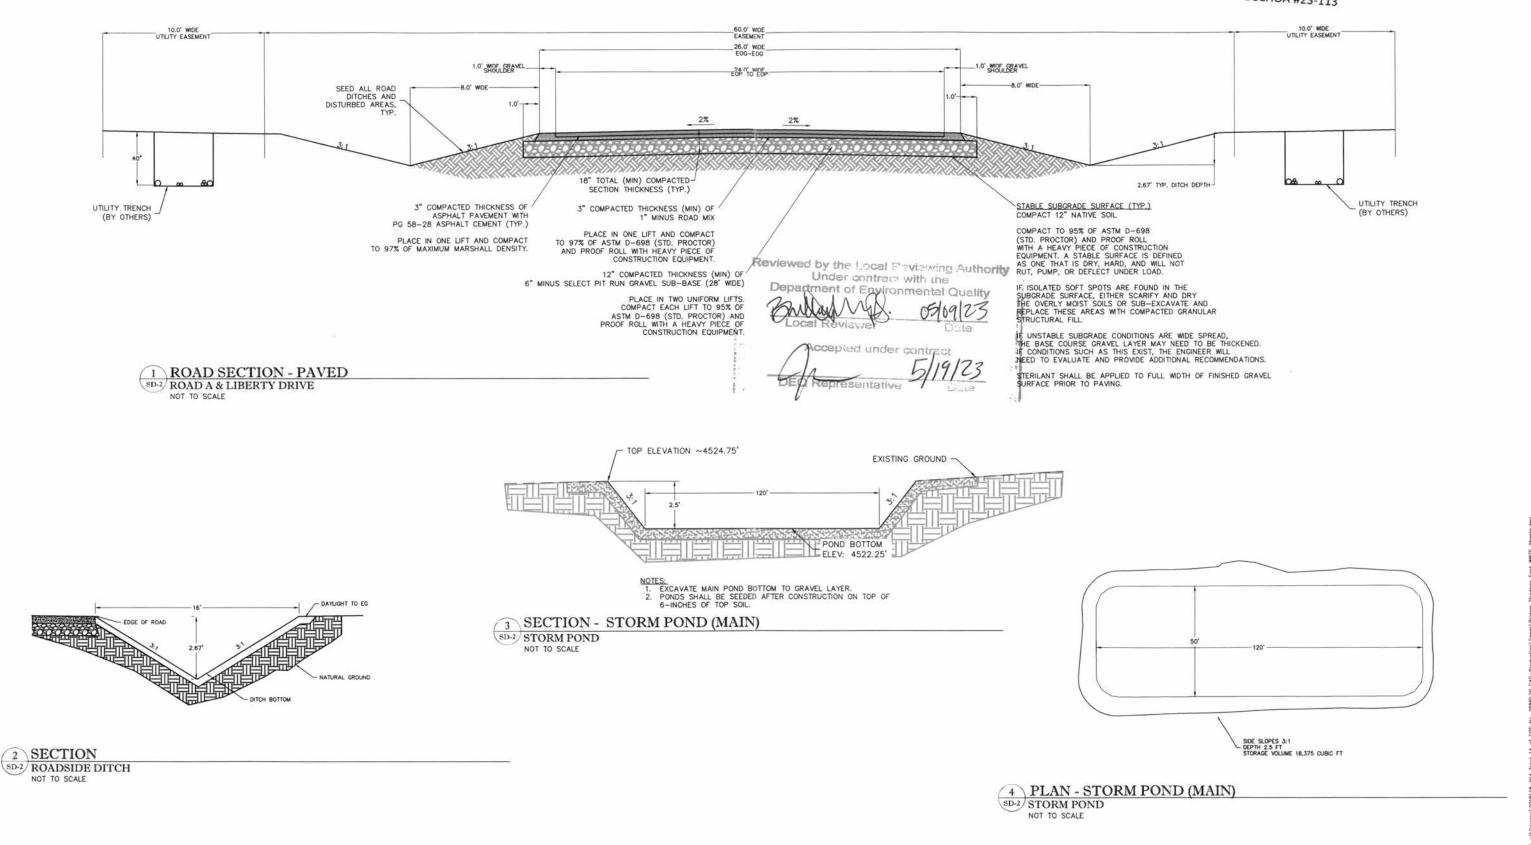
# BRIDGER SHADOWS EAST **GENERAL DETAILS**

NE 1/4 SEC 19 & NW 1/4 SEC 20, T1S, R5E, P.M.M., GALLATIN COUNTY

32 DISCOVERY DRIVE BOZEMAN, MT 59718 PHONE (406) 582-0221 FAX (406) 582-5770 www.alliedengineering.com

Civil Engineering Geotechnical Engineering Land Surveying



ı	PROJE	CT #:18-014.2
Ī	DATE:	03/03/2023
- 1		

BRIDGER SHADOWS EAST

SHEET

WW-4